
Rev. Date

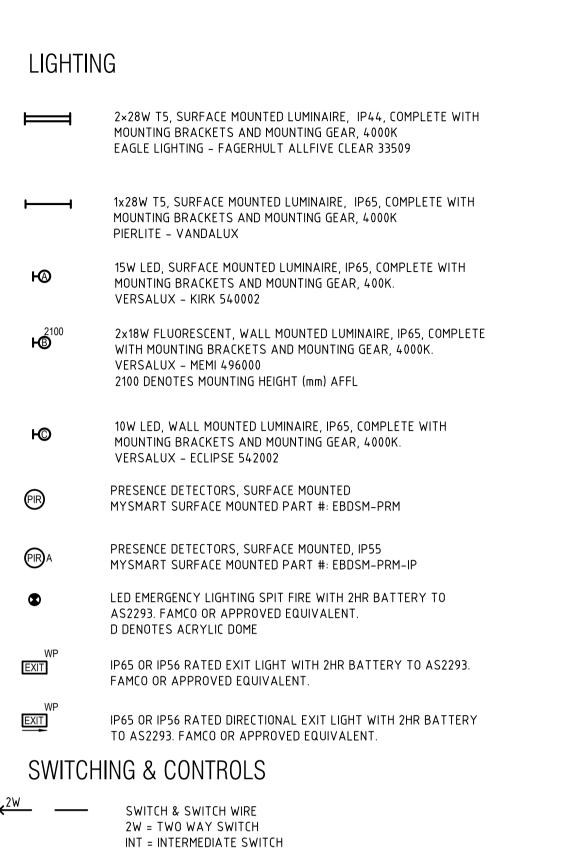

EXTERNAL LIGHTING CONTROL. PE CELL

WITH TIME SWITCH OVERRIDE

EXISTING MAINSWITCH BOARD (MSB)

PROPOSED DISTRIBUTION BOARD (DB)

DOUBLE GENERAL PURPOSE SOCKET OUTLET

SINGLE GENERAL PURPOSE SOCKET OUTLET

3N DENOTES THREE PHASE PLUS NEUTRAL, 1N DENOTES ONE PHASE PLUS NEUTRAL

PERMANENTLY CONNECTED ISOLATOR

20A DENOTES RATING

NO. OF POLES OCCUPIED

—— DISTRIBUTION BOARD NUMBER

DBX-XXX-Y CIRCUIT DESIGNATION

----- CIRCUIT NUMBER

COMMUNICATIONS

SINGLE LINE DIAGRAM

— ISOLATOR/SWITCH

ABBREVIATIONS

HWU HOT WATER UNIT

25A CURRENT RATING

TEF TOILET EXHAUST FAN

CL CLEANERS' OUTLET

FIP FIRE INDICATOR PANEL

EF EXHAUST FAN

ZIP ZIP UNIT BBQ BARBEQUE S SENSOR

WP WEATHERPROOF IP65 OR IP56

PUMP ELECTRICALLY POWERED PUMP

1100 MOUNTING HEIGHT IN TERMS OF mm AFFL

AB MOUNTED AT 150mm ABOVE BENCH

EXISTING COMMUNICATIONS PIT

MAIN DISTRIBUTION FRAME

CIRCUIT BREAKER

SINGLE PHASE


THREE PHASE

30mA RCD CIRCUIT BREAKER

CURRENT TRANSFORMER


SCHNEIDER PM5340)

DIGITAL POWER METER(EQUIVALENT TO

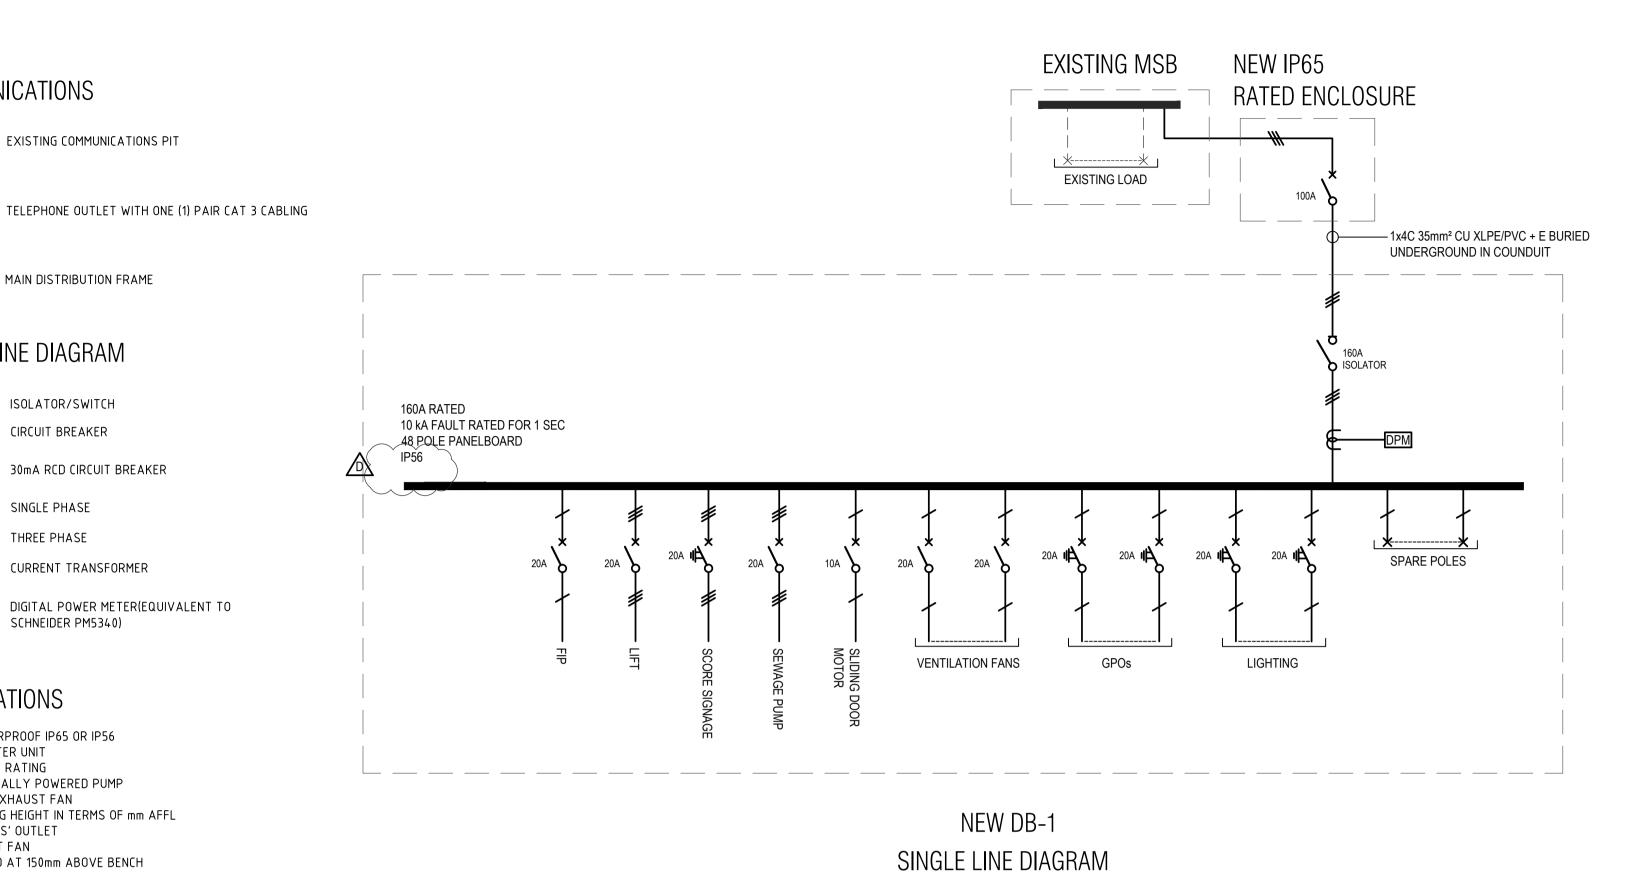

POWER NOTES (TYPICAL):

- ABOVE SINGLE LINE DIAGRAM IS NOT TO BE TAKEN AS EXHAUSTIVE, SHOWN FOR CONSIDERATION ONLY.
- CIRCUIT BREAKER RATINGS NOTED ARE INSTALLED FULL LOAD RATINGS. SIZE ACTUAL CIRCUIT BREAKERS ALLOWING FOR DERATING FACTORS. PROVIDE CALCULATIONS TO DEMONSTRATE FINAL SELECTION. CIRCUIT BREAKERS SHALL PROVIDE FULL DISCRIMINATION.
- CIRCUIT BREAKERS SHALL PROVIDE FAULT LEVEL CASCADE PROTECTION TO ENABLE THE USE OF 10kA MINIATURE CIRCUIT BREAKERS.
- SUB-MAINS CABLE SHALL BE INSTALLED IN ACCORDANCE WITH AS3008.
- SEPARATE EARTH CABLES SHALL BE PROVIDED IN ACCORDANCE WITH AS/NZS3000 TABLE 5.1.
- SUB-MAINS CABLE IDENTIFICATION TAGS SHALL BE PROVIDED AT SOURCE, TERMINATION AND ON EITHER SIDE OF ANY BARRIER.
- MAXIMUM FINAL SUB-CIRCUIT LENGTH SHALL BE IN ACCORDANCE WITH AS/NZS3000 TABLE B5.1 FOR TYPE C MCB'S. TYPICALLY ACTIVE 2.5 sq. mm. Cu PVC/PVC, EARTH 2.5 sq. mm PVC/PVC, 20A 68m. MAXIMUM FINAL SUB-CIRCUIT VOLTAGE DROP SHALL NOT EXCEED 2.5%
- 10. SOCKET OUTLETS: IN GENERAL FINAL SUB-CIRCUITS SHALL NOT SERVE AREAS ON MORE THAN ONE LEVEL. CLEANERS AND MAINTENANCE SOCKET OUTLETS SHALL BE DEDICATED CIRCUITS. MAXIMUM 16 SOCKET OUTLETS PER FINAL SUB-CIRCUIT. SOCKET OUTLETS SUPPLYING NAMED EQUIPMENT SHALL BE SUPPLIED VIA SEPARATE DEDICATED FINAL SUBCIRCUITS. FOR EXAMPLE: HWU/BWU, MATV, SECURITY, COMMS EQUIPMENT ETC.
- 11. ENSURE ALL THERMAL OR ACOUSTIC INSULATION MATERIALS, OTHER THAN THOSE THAT ARE FULLY ENCLOSED WITHIN PARTITION LININGS, ARE PHYSICALLY SECURE SO AS NOT TO BE DISLODGED DURING NORMAL USE AND MAINTENANCE OF THE BUILDING.

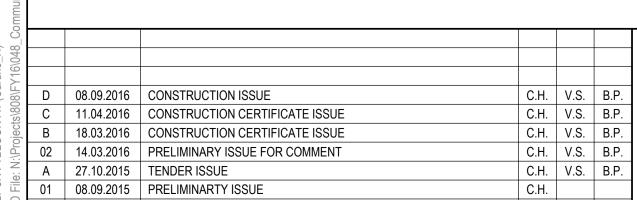

Description

Des. Verif. Appd.

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Drawn C.O.	Date Sept '16	BRIARS SPORTING CLUB				
Checked M.D.	Date Sept '16	Project COMMUNITY AND AMENITIES BUILDING	Status EOD CO	ONSTRUCTION	ON.	
Designed C.O.	Date Sept '16	ROTHWELL PARK, CONCORD	FOR CO			
Verified L.K.K	Date Sept '16	Title ELECTRICAL SERVICES		Scale NTS	Size A1	
Approved		LEGEND AND SINGLE LINE DIAGRAM	Drawing Number	-	Revision	
B.P.	Sept '16		8081604	80816048-EL-0001		